# City of Cranston Zoning Board of Review Application

Application for exception or variation under the zoning ordinance "City of Cranston Zoning Code, December 1994 Edition as amended."

Cranston Zoning Board of Review Date: October 8, 2021 35 Sockanosset Crossroad Suite 6 Cranston, RI 02920 THE UNDERSIGNED HEREBY APPLIES TO THE ZONING BOARD OF REVIEW FOR AN EXCEPTION OR A VARIATION IN THE APPLICATION OF THE PROVISIONS OR REGULATIONS OF THE ZONING ORDINANCE AFFECTING THE FOLLOWING DESCRIBED PREMISES IN THE MANNER AND ON THE GROUNDS HEREINAFTER SET FORTH. VEREIT REAL ESTATE L.P. OWNER: \_ ZIP CODE: \_85016 2325 East Camelback Road, Phoenix, AZ ADDRESS: APPLICANT: Volta Charging, LLC ("Volta") ADDRESS: 155 De Haro Street, San Francisco, CA ZIP CODE: 94103 LESSEE: Stop & Shop ADDRESS: 1385 Hancock Street, Quincy, MA ZIP CODE: 02169 1. ADDRESS OF PROPERTY: 275 WARWICK AVENUE, CRANSTON, RI 02905 BLOCK #: ASSESSOR'S LOT #: 2659 WARD: 1 2. ASSESSOR'S PLAT #: 4 3. LOT FRONTAGE: 577 FT \_\_\_\_ LOT DEPTH: \_\_\_\_\_ LOT AREA: \_\_7.46 AC 4. ZONING DISTRICT IN WHICH PROPERTY IS LOCATED: C-5 (AREA LIMITATION) (HEIGHT LIMITATION) PROPOSED: NO CHANGE 5. BUILDING HEIGHT, PRESENT: PROPOSED: NO CHANGE 6. LOT COVERAGE, PRESENT: \_ 7. HOW LONG HAVE YOU OWNED THE ABOVE PREMISES? Applicant is sub-tenant. Owner has owned parcel since August 9, 2011. 8. ARE THERE ANY BUILDINGS ON THE PREMISES AT PRESENT? YES 9. GIVE SIZE OF EXISTING BUILDING(S): 54,663 SF 10. GIVE SIZE OF PROPOSED BUILDING(S): N/A 11. WHAT IS THE PRESENT USE? LRG BUS MDL94 - SUPERMARKET 12. WHAT IS THE PROPOSED USE? N/A 13. NUMBER OF FAMILIES FOR WHICH BUILDING IS TO BE ARRANGED:  $0^{N/A}$ 

DocuSign Envelope ID: DF90A402-1E95-4C65-A02F-83B154742A5F 14. DESCRIBE IN DETAIL THE EXTENT OF PROPOSED ALTERATIONS: (2) standard parking stalls are to be converted into 2 standard electric vehicle (EV) parking stalls. (2) electric vehicle charging stations are to be installed in landscape islands adjacent to the EV parking stalls. Electrical conduits will be extended from the existing building to the electric vehicle charging stations. Volta will also paint and mark all EV charging parking stalls and install necessary parking signs 15. HAVE YOU SUBMITTED PLANS TO THE BUILDING OFFICIAL? NO 16. WERE YOU REFUSED A PERMIT? NO 17. PROVISION OR REGULATION OF THE ZONING ORDINANCE OR STATE ENABLING ACT UNDER WHICH APPLICATION FOR EXCEPTION OR VARIANCE IS MADE. Volta respectfully requests variance relief from the terms of Section 17.20.010, 17.20.030, 17.72.010 and 17.72.010(6) pursuant to Section 17.92.010 of the City of Cranston Zoning Ordinance and Rhode Island General Laws Title 45, Chapter 45-24, Section 45-24-41 and such other relief as deemed necessary. Please refer to the Supporting Statement submitted herewith 18. STATE GROUNDS FOR EXCEPTION OR VARIANCE IN THIS CASE; and incorporated herein by reference. SIGNATURE OF APPELLANT(S) AND ATTORNEY (IF APPLICABLE) IS REQUIRED AND MUST BE LEGIBLE. RESPECTFULLY SUBMITTED, Please refer to Letter of Authorization submitted herewith (OWNER SIGNATURE) (PHONE NUMBER) (PHONE NUMBER) (OVP) POPER OF THE Michael B Hershberg 978-766-7770 (APPETERNT SIGNATURE) (PHONE NUMBER) Guy Stutz (PHONE NUMBER) (LESSEE SIGNATURE) 401-276-2639 (ATTORNEY SIGNATURE) (PHONE NUMBER) Edward D. Pare, Jr., Esq., Brown Rudnick LLP For the Applicant (ATTORNEY NAME-PLEASE PRINT) ATTORNEY ADDRESS: 10 Memorial Boulevard, Providence, Rhode Island 02903 PRE-ZONING APPLICATION MEETING: (PLANNING DEPT. SIGNATURE) (DATE)



July 22, 2021

RE: Stop & Shop – 275 Warwick Ave., Cranston, RI 52137 (Property)

To Whom It May Concern:

VEREIT Real Estate, L.P. (Owner) as owner of the above-referenced Property hereby designates The Stop & Shop Supermarket Company LLC (Tenant) as an authorized representative of Owner to submit on behalf of Owner the necessary application as it applies for the proposed improvements (Installation of Electric Vehicle Charging Stations) for the Property.

Contracting Company: VOLTA CHARGING LLC

155 De Haro

San Francisco, CA 94103

Dawn Zancan – <u>Dawn.Zancan@voltacharging.com</u>

Tenant is not authorized to execute any final plats, maps or written agreements that would bind Owner.

VEREIT Real Estate, L.P., a Delaware limited partnership (successor by merger to SS Cranston RI, LLC)

By: VEREIT Real Estate GP, LLC, a Delaware limited liability company, Its General Partner

By:

VEREIT

Teresa Jenkins 2021.07.22 08:10:59 -07'00'

Name: Teresa Jenkins Title: Authorized Officer



## **brown**rudnick

Edward D. Pare, Jr., Esq. direct dial: 401-276-2639 epare@brownrudnick.com

September 2, 2021

City of Cranston Zoning Board of Review 35 Sockanosset Crossroad, Suite 6 Cranston, RI 02920

RE: Application for Variance – Electric Vehicle Charging Stations

Applicant: Volta Charging, LLC ("Volta" or the "Applicant")

Site: Stop & Shop Parking Lot at 275 Warwick Avenue (Assessor's

Parcels 4-2659-0, the "Site")

Zoning District: Commercial C5

Owner: VEREIT REAL ESTATE L.P.

Relief Requested: Variance from the terms of Sections 17.20.010, 17.20.030,

17.72.010 and 17.72.010(6) pursuant to Section 17.92.010 of the City of Cranston Zoning Ordinance (hereinafter, the "Ordinance") and Rhode Island General Laws, Title 45, Chapter 45-24, Section 45-24-41, and such other relief as deemed necessary, all rights reserved, for the installation, operation, and maintenance of two

electric vehicle charging stations on the Site.

Dear Honorable Members of the City of Cranston Zoning Board of Review:

On behalf of Volta, we are pleased to submit this letter to the City of Cranston Zoning Board of Review (the "Board") in support of the application by Volta for variance relief for the installation, operation, and maintenance of two electric vehicle charging stations. The following provides background information regarding the charging stations and addresses the applicable sections of the Ordinance.

## **BACKGROUND**

Volta was founded in 2010 out of a passion for advancing electric transportation and since then, Volta has mastered the art and science of developing cutting-edge electric vehicle charging networks. By providing seamless, simple and free electric vehicle charging experiences for customers of the businesses where Volta is located, Volta is accelerating the electric vehicle movement. Thoughtfully located along the paths of daily life, Volta chargers are the most



City of Cranston Zoning Board of Review September 2, 2021 Page 2

heavily used in the charging industry. With the support of forward-thinking brand partners, Volta delivers free charging solutions to real estate owners, power to the electric vehicle community, efficient use of customers' time and impactful brand stories to everyone. <a href="https://www.voltacharging.com">www.voltacharging.com</a>

The Volta charging station experience is a unique concept because Volta does not charge fees or costs to customers for the electricity but gives it away to encourage the use of electric vehicles. As the electricity ultimately must be purchased, Volta sells advertising space to brand name advertisers on the screens on its charging stations to generate the revenue needed to pay for the electricity. Notable advertising partners include Netflix, Jaguar, Alaska Airlines and Haagen Dazs. The advertisements shown on the screens are an integral part of the charging station and the electricity would not be available at no cost to the public without them.

Volta currently has nearly 1,500 charging stations installed throughout the United States including many in Massachusetts in the following communities: Burlington, Barnstable, Marlborough, Northborough, Framingham, Natick, Boston, Wakefield and Belmont. Charging stations are typically situated near retailers such as grocery stores. In Rhode Island, Volta has charging stations at Stop & Shop locations in Coventry and Pawtucket and at the Providence Place Mall.

For example, charging stations were recently installed in front of a Star Market grocery store in Belmont, Massachusetts and the feedback has been terrific:

"I'm sure that you will be delighted to hear that the customer reception has been incredible! Yesterday as a user at one station pulled out, another customer pulled right in! This morning I was paged to the service desk to receive more accolades from a customer about how "Great Star Market Is" to be on the forefront with these stations." Steve Duran, Store Director, Belmont Star Market

"I just want to thank you for bringing free Electrical Vehicle charging stations to my local Star Market in Belmont, MA. It is very convenient for me and helps to get the word out that electric vehicles are practical as well as environmentally desirable. The charging units are conveniently placed within the parking lot and have been well maintained. I hope the program expands and would especially like to see units where I typically spend more time."

S. Harris, Electric Vehicle Owner, Belmont, MA

Volta is also proud of its commitment to assist local communities with displaying emergency messaging on its charging station screens. The Volta Response System allows participating municipalities to show public service announcements and emergency messaging at no cost. This community service allows municipalities to reach communities such as the elderly, without expending local government resources on signs, ad space or media outlets.



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The clean energy impact from the Volta charging stations is immense:

- Powering over 73,000,000 free electric miles.
- To date, Volta has offset over 32,000,000 pounds of CO2.
- Total equivalent of over 369,000 trees planted.
- Volta charging stations are the most used in the charging industry.

## THE SITE

Volta proposes to install two electric vehicle charging stations at the Stop & Shop parking lot Site at 275 Warwick Avenue, capable of providing free electricity to the public to charge electric vehicles. The charging units will measure approximately 36.5" wide by 84.9"5' high. On each face of the charging unit, there is a screen for advertisements, measuring 55" diagonally by 27" (48" in height). The ads are stationary and change approximately every eight seconds. These are not video or moving displays but stationary images and there is no sound or noise emitted from the stations. The screens are backlit, similar to a TV screen and target pedestrians, not drivers. Although the display screens are intended for pedestrian traffic, out of an abundance of caution Volta follows an eight-second minimum advertisement loop which is the length of time recommended by the Federal Highway Administration.

The two (2) proposed charging stations will not have an adverse impact upon the aesthetics of the area. The charging stations are located within the parking lot near the existing Stop & Shop and set back from the road. The advertisements are not intended for those traveling along the public ways but for those visitors and shoppers at the Stop & Shop. This is a beneficial, accessory and "green" use. Volta targets areas where customers are shopping so they can efficiently use their time in the store to recharge their electric vehicles, at no cost to boot. Only two existing parking spaces will be converted into parking spaces for electric vehicles at the charging stations. Those parking spaces are not eliminated, just designated for electric vehicle charging use.

The charging stations are located near the Stop & Shop grocery store building, with additional existing parking spaces between. One charging station is about 80' from Warwick Avenue and the second, approximately 80' from the rear property line. Given the distance to the street and rear property line, and existing obstructions on the Site, the proposed electric charging stations will have negligible visual impacts on the neighborhood while providing cutting edge "green" benefits to the public.



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## RELIEF REQUESTED

As the Board knows, the Ordinance does not provide for electric vehicle charging stations such as these. We have attempted to request relief under the existing Ordinance based on existing uses and dimensional requirements. Therefore, Volta respectfully requests all necessary variances from the terms of Sections 17.20.010, 17.20.030, 17.72.010 and 17.72.010(6) pursuant to Section 17.92.010 of the Ordinance and Rhode Island General Laws Title 45, Chapter 45-24, Section 45-24-41, and such other relief as deemed necessary, all rights reserved, for the installation, operation, and maintenance of two (2) electric vehicle charging stations. We believe these stations should be considered full-service fuel stations and approved as charging stations, similar to other accessory uses. However, based upon discussions with the City's Zoning Official, we understand these charging stations would fall under the sign provisions of the Ordinance. Anticipating that these would be considered "monument" signs, these charging stations comply with the maximum square footage and setback requirements; however, the charging station as a whole is approximately seven feet (7') in height, in excess of four feet (4') allowed under the sign Ordinance for the C-5 (Heavy Business, Industry) zoning district. Of course, the excess height is due to the charging station base and equipment, not the sign itself. We are confident that if the two uses were separated, we could install a monument sign on the Site and charging stations which charge a fee or where customers incur costs for charging their electric vehicles. As will be further demonstrated by Volta by evidence submitted to the Board at the public hearing(s) in connection herewith, such relief is appropriate as the charging stations satisfy all pertinent provisions and standards contained in the Ordinance and Rhode Island General Laws for the granting of variances as enumerated below.

## COMPLANCE WITH SECTION 17.92.010 OF THE ORDINANCE

- B. In granting a variance, the zoning board of review shall require that evidence to the satisfaction of the following standards be entered into the record of the proceedings:
  - 1. That the hardship from which the applicant seeks relief is due to the unique characteristics of the subject land or structure and not to the general characteristics of the surrounding area; and is not due to a physical or economic disability of the applicant;
    - The hardship is owing to the unique characteristics of the land and its use as a shopping plaza, which renders the proposed location uniquely suited for the electric vehicle charging stations as there is ample room on the Site and the existing parking lot is an appropriate location for this "green" technology designed to charge electric vehicles, free of charge. If the charging stations are not allowed on the Site, Volta cannot offer cost-free electricity to the public and the



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clean energy benefits of Volta's electric vehicle charging stations will not be realized. Volta has designed its charging stations to be as small as possible and the provisions of the Ordinance relating to the size of monument signs would not allow both the electric charging station and the advertising screen. Without the relief, the opportunity for free electric vehicle charging would not be allowed.

2. That the hardship is not the result of any prior action of the applicant and does not result primarily from the desire of the applicant to realize greater financial gain;

The hardship does not result from Volta's prior actions. The electricity is offered to the public free of charge. If the electric vehicle charging stations are not allowed to function, Volta cannot offer the free electricity to the public and the clean energy benefits of Volta's electric charging stations will not be realized.

That the granting of the requested variance will not alter the general character of the surrounding area or impair the intent or purpose of the zoning ordinance codified in this title or the comprehensive plan upon which the ordinance is based; and

The requested variance relief will not alter the general character of the surrounding area or impair the intent or purpose of the Ordinance because the Stop & Shop parking lot location is uniquely suited for the electric vehicle charging stations. There is ample room on the Site and the locations for this new technology are appropriate and generally screened from view, except for those visiting the Site. The size of the Site, along with the existing building, plantings, vehicles in the parking lot, and setbacks will help screen the electric charging stations from view from the nearby roads and neighboring properties, thereby preserving the aesthetic qualities of the City of Cranston. The charging stations will provide a significant public benefit in the form of free electricity, which promotes the use of green energy and electric vehicles. These unmanned electric charging stations will not create a hazard or nuisance to abutters, vehicles, pedestrians, or the environment because the use is passive in nature and will not produce unreasonable noise, smoke, odors, or waste. The electric vehicle charging stations are designed to line up with the existing parking patterns and pedestrian use of the parking lot, will not pose a hazard to pedestrians or vehicles, and will not interfere with existing traffic patterns on the Site. The existing parking spaces will remain in place, just designated as spaces for electric vehicles seeking a charge. The variance will comply with the City of Cranston's Comprehensive Plan (the "Comp Plan") through the use of "green" energy and development. Consistent with the Comp Plan, the charging stations will promote orderly growth and development that recognizes the natural characteristics of the land, its suitability for use, and the availability of existing and proposed public and/or private services and facilities. Likewise, the charging stations are innovative improvements that promote the development of land suitable for development while



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protecting the natural, cultural, historical, and recreational resources while achieving a balanced pattern of land uses and the opportunity to reduce impacts to the environment, improve building efficiency, and lower utility bills by encouraging the construction of green buildings.

4. That the relief to be granted is the least relief necessary.

The relief sought is the least relief necessary to provide space for the electric vehicle charging station with the advertising area necessary to recover the cost of the free electricity.

- C. The zoning board of review shall, in addition to the above standards, require that evidence be entered into the record of the proceedings showing that:
  - 1. In granting a use variance the subject land or structure cannot yield any beneficial use if it is required to conform to the provisions of the zoning ordinance. Nonconforming use of neighboring land or structures in the same district and permitted use of lands or structures in an adjacent district shall not be considered in granting a use variance; and, in granting a dimensional variance, that the hardship that will be suffered by the owner of the subject property if the dimensional variance is not granted shall amount to more than a mere inconvenience, which shall mean that there is no other reasonable alternative to enjoy a legally permitted beneficial use of one's property. The fact that a use may be more valuable after the relief is granted shall not be grounds for relief.

As discussed above, the electricity to charge electric vehicles is offered to the public free of charge. If the electric charging stations are not allowed to function and include the advertising screens, then Volta cannot offer the free electricity to the public and the clean energy benefits of Volta's electric charging stations will not be realized.

## **CONCLUSION**

As evidenced by the materials submitted with this Application and as will be further demonstrated by the Applicant through evidence submitted to the Board at the public hearing(s) in connection herewith, the proposed electric vehicle charging stations satisfy the intent and objectives of the Ordinance in light of the size of the parcel, the commercial nature of the shopping plaza, as well as the charging station placement within the Site and the provision of free electricity for electric vehicles. The electric vehicle charging stations will minimize any potential adverse impact to the surrounding neighborhood and the City of Cranston as a whole as the advertisements are targeted to the shoppers and will not generally be visible from public




City of Cranston Zoning Board of Review September 2, 2021 Page 7

ways or neighboring parcels. Volta respectfully requests that the Board approve the two (2) electric vehicle charging stations by granting the requested variance relief. We are sure the Board agrees that these new, cutting edge "green" technologies will continue to develop over time based on the foundation of acceptance and approvals pursuant to a forward-looking municipality.

Respectfully Submitted,

BROWN RUDNICK LLP

Edward D. Pare, Jr., Esq.

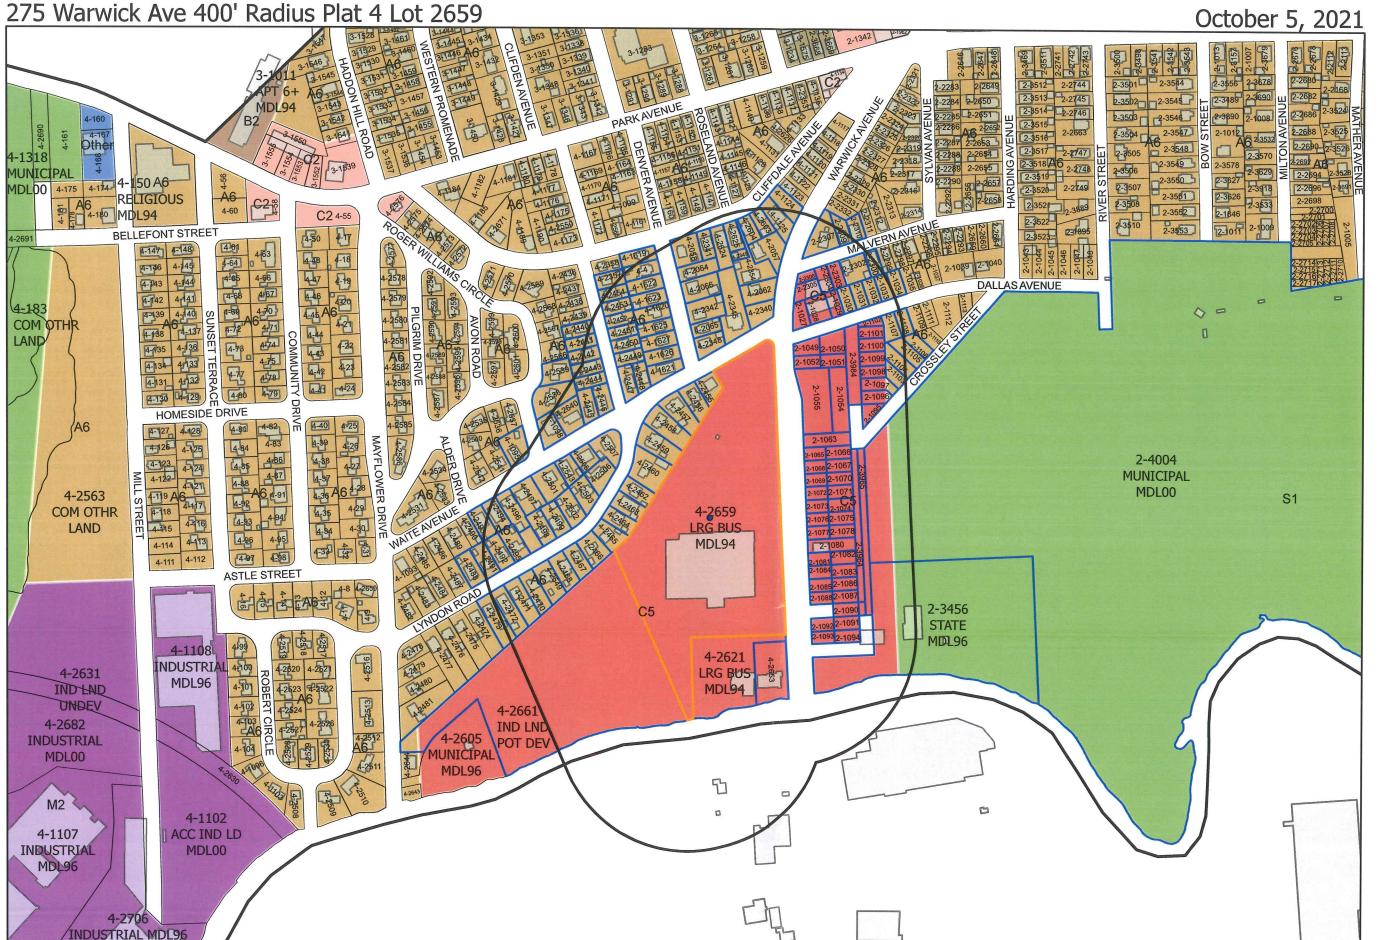



Buildings
Cranston Boundary
Cranston Parcels

Zoning
none
A80
A20
A12
A8
A6
B1
B2
C1
C2
C3
C4
C5
M1
M2
EI
EI
MPD
S1
Other
Historic Overlay District
BufferParcels\_ToExcel\_Feature\_Set\_Points
Parcels in Radius
Lot 2659
J400' Radius

# VOLTA

# STOP & SHOP #2702 CRANSTON

275 WARWICK AVENUE CRANSTON, RI 02905 CITY OF CRANSTON PARCEL: 4-2659-0

ITEM	TASK	YES	NO	N/A
1	CONTACT 811 UTILITY PRIOR TO EXCAVATION WORK.			
2	NOTIFY VOLTA & KIMLEY-HORN OF ANY DISCREPANCIES W/ PLANS OR POTENTIAL CONFLICTS.			
3	VERIFY ALL FIELD CONDITIONS PRIOR TO START OF CONSTRUCTION IN ACCORDANCE WITH THESE PLANS.			
4	INSTALL WORK AREA PROTECTION MEASURES.			
5	FIELD LOCATE EXISTING UTILITIES AND CROSSINGS & VERIFY NO CONFLICTS W/PROPOSED INFRASTRUCTURE.			
6	FIELD VERIFY ALL STALL DIMENSIONS AND EQUIPMENT LOCATIONS.			
7	CONFIRM ALL ADA AND LOCAL REQUIREMENTS ARE MET.			
8	ESTABLISH TEMPORARY CONSTRUCTION ACCESS(ES).			
9	IMPLEMENT AND MAINTAIN EPSC CONTROL MEASURES PER LOCAL REQUIREMENTS.			
10	LOCATE VERTICAL AND HORIZONTAL UTILITIES PRIOR TO BORING.			
11	PROVIDE PROPOSED LIMITS OF ASPHALT OVERLAY SKETCH TO KIMLEY-HORN & VOLTA (IF NEEDED).			
12	SEED & STABILIZE ALL DISTURBED AREAS AFTER FINAL GRADING.			

ALL WORK AND MATERIALS SHALL BE PERFORMED AND INSTALLED IN ACCORDANCE WITH THE CURRENT EDITIONS OF THE BUILDING/VORLLING, STRUCTURAL, PLUMBING, MECHANICAL, ELECTRICAL, AND FIRE/LIFE SAFETY CODES AS ADOPTED BY THE LOCAL GOVERNING AUTHORITIES. NOTHING IN THESE PLANS IS TO BE CONSTRUCTED TO PERMIT WORK NOT CONFORMING TO THE LOCAL GOVERNING AUTHORITIES CODES.

LOCAL MAP

2 STANDARD PARKING SPACES ARE TO BE CONVERTED INTO 2 STANDARD ELECTRIC VEHICLE (EV) PARKING SPACES, 2 ELECTRIC VEHICLE CHARGING STATIONS ARE TO BE INSTALLED IN LANDSCAPED ISLANDS ADJACENT TO THE EV PARKING STALLS, ELECTRICAL CONDUITS WILL BE EXTENDED FROM THE EXISTING BUILDING TO THE ELECTRIC VEHICLE CHARGING STATIONS, VOLTA WILL ALSO PAINT AND MARK ALL EV CHARGING PARKING SPACES AND INSTALL NECESSARY PARKING SIGNS.

VOLTA REPRESENTATIVE:

VOLIA 155 DE HARO STREET SAN FRANCISCO, CA 94103 CONTACT: MICHAEL HERSBHERG PHONE: (978) 766-7770

AIL: MICHAEL.HERSHBERG@VOLTACHARGING.COM

SITE PARTNER:
STOP & SHOP
1385 HANCOCK ST
QUINCY, MA 02169
CONTACT: LINDA CARMARA
PHONE: (508)-654-6851
EMAIL: LCAMARA@STOPANDSHOP.COM

OVINIER.
SS CRANSTON RI LLC C/O AHOLD FINANCIAL SERVICES
P.O BOX 6500, CARLISLE, PA 17013 ATTN:
LEASING ACCOUNTING


PROGRAM MANAGER:
KIMLEY-HORN & ASSOCIATES
CONTACT: RYAN GRAM
PHONE: (615)-564-2865
EMAIL: RYAN.GRAM@KIMLEY-HORN.COM

CIVIL ENGINEER:
KIMLEY-HORN & ASSOCIATES
CONTACT: MIKE JUNGHANS, P.E.
PHONE: (914)-368-9189
EMAIL: MIKE.JUNGHANS@KIMLEY-HORN.CO)

ELECTRICAL ENGINEER:
KIMLEY-HORN & ASSOCIATES
CONTACT: JEFFREY SALLEE, P.E.
PHONE: (757)-213-B635
EMAIL: JEFFREY.SALLEE@KIMLEY-HORN.COM

ISSUE DATE

PROJECT DESCRIPTION

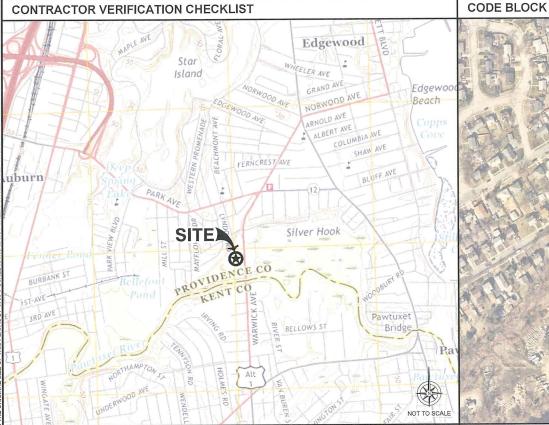

**VICINITY MAP** 



## **PROJECT TEAM**

Sheet Number	Sheet Title
C0-00	COVER SHEET
C0-01	GENERAL NOTES
C0-02	VOLTA STATION OVERVIEW
C1-00	OVERALL SITE PLAN
C2-00	ENLARGED SITE PLAN
C3-00	SITE DETAILS
C3-01	SITE DETAILS
C3-02	SITE DETAILS
E1-00	ELECTRICAL ONE LINE DIAGRAM & PANEL SCHEDULE
E2-00	ELECTRICAL NOTES & DETAILS

#### SHEET INDEX



**DIG ALERT** 

Know what's BELOW. CALL before you dig.

CALL AT LEAST TWO WORKING DAYS BEFORE YOU DIG

CONTRACTOR SHALL VERIFY ALL PLANS & EXISTING LOCATIONS, CONDITIONS ON THE JOE SITE & SHALL IMMEDIATELY NOTIFY THE ENGINEER IN WRITING OF ANY DISCREPANCIES BEFORE PROCEEDING WITH THE WORK OR BE RESPONSIBLE FOR SAME

**CALL BEFORE YOU DIG** 



155 DE HARO STREET



1 N LEXINGTON AVE, SUITE 505 WHITE PLAINS, NY 10601 Main: 914,368,9200 | www.kimley-horn.c

REV	DATE	DESCRIPTION	BY
$\triangle$	01/21/2021	CD90s	TAS
2	03/18/2021	CD100s	TAS
3	09/15/2021	CD100 REVISION TO V4	CGE

09/15/2021

ISSUED FOR

PERMIT



DIRECTION OF A LICENSED PROFESSIONAL ENGINEER, TO ALTER THIS DOCUMENT.

**STOP & SHOP #2702 CRANSTON** 

**275 WARWICK AVENUE** CRANSTON, RI 02905

SHEET TITLE

**COVER SHEET** 

**CO-00** 

#### **GENERAL NOTES:**

- VOLTA WILL PROVIDE AN INSTALLATION GUIDE AND OTHER SUPPORTING DOCUMENTS AT TIME OF
- ALL EXISTING CONDITIONS SHOWN ARE APPROXIMATE. EXISTING UTILITY LOCATIONS AND CROSSINGS ARE TO BE LOCATED IN THE FIELD. CONTRACTOR IS TO CONTACT 811 UTILITY PRIOR TO BEGINNING ANY
- ALL PAVEMENT, LANDSCAPING, UTILITIES, AND OWNER PROPERTY THAT IS DAMAGED OR AFFECTED BY STRUCTION SHALL BE RETURNED TO EXISTING CONDITIONS OR BETTER AT THE CONTRACTOR'S
- EAF-EIGE.
  PROPOSED PAVEMENT STRIPING SHALL LINE UP WITH EXISTING STRIPING WHEREVER POSSIBLE,
  ADDITIONAL PAVEMENT STRIPE IS NOT NECESSARILY PARALLEL TO THE CONSTRUCTED CHARGIN
- ISLAND
  THIS ACCESSIBILITY REVIEW WAS UNDERTAKEN TO IDENTIFY DESIGN FEATURES OF THE PROJECT THAT
  MAY BE CONSIDERED BY GOVERNMENTAL AGENCIES OR DEPARTMENTS, OR NON-GOVERNMENTAL
  GROUPS TO BE NON-COMPLIANT WITH THE AMERICANS WITH DISABILITIES ACT OF 1990, REVISED 2010
  ADA REGULATIONS AND STANDARDS. THE AMERICANS WITH DISABILITIES ACT OF 1990 IS A FEDERAL
  CIVIL RIGHTS LAW, THERE IS NO FEDERAL REVIEW PROCESS TO ENSURE FULL COMPLIANCE WITH THE
  GUIDELLINES, EXCEPT THROUGH THE FEDERAL COUNTY SYSTEM. THE DEPICTIONS, NOTES, AND
  RECOMMENDATIONS, EXPRESSED ON THIS PLAN ARE BASED ON PROFESSIONAL JUDGEMENT GAINED
  FROM BASE TEXPERIENCE WITH ACCESSIBILITY LAWS. CODES AND STANDARDS AND THE WORKING FROM PAST EXPERIENCE WITH ACCESSIBILITY LAWS, CODES, AND STANDARDS AND THE WORKING INVOLVEMENT TO DEVELOP ACCESSIBILITY STANDARDS THAT WILL MEET OR EXCEED THE APPLICABLE FEDERAL GUIDELINES. ACCORDINGLY, NO CLAIMS OR WARRANTIES, EXPRESSED OR IMPLIED, ARE MADE THAT IN PREPARING THIS PLAN AND PROPOSING RECOMMENDATIONS, THAT ALL POSSIBLE BARRIERS TO ALL PEOPLE HAVE BEEN IDENTIFIED.
- CONTRACTOR SHALL ACHIEVE A MINIMUM OF 1% BUT NO MORE THAN A 2% SLOPE IN ANY DIRECTION CONTRACTOR SHALL ACHIEVE A MINIMUM OF 1% BUT NO MORE THAN A 2% SLOPE IN ANY DIRECTION WITHIN ADJACENT ACCESSIBLE SPACE AND BLEND ASPHALT OVERLAY TO EXISTING GRADES AS REQUIRED. CONTRACTOR SHALL PROVIDE A SKETCH TO VOLTA OF PROPOSED LIMITS OF ASPHALT OVERLAY TO ACHIEVE THIS REDUIREMENT PRIOR TO BEGINNING PAYEMENT WORK.

  ACCESSIBLE EV STALLS WERE DESIGNED BASED ON EXISTING CONDITIONS AND WITHOUT THE BENEFIT OF SURVEY DATA. ALL ADA AND LOCAL REQUIREMENTS INCLUDING BUT NOT LIMITED TO SLOPE AND SPACING SHALL BE CONFIRMED BY THE CONTRACTOR AND MET AT THE TIME OF CONSTRUCTION.

  CONTRACTOR TO NOTIFY THE ENGINEER OF ANY DISCREPANCIES IN ACCESSIBILITY PRIOR TO CONSTRUCTION.

- CONSTRUCTION.

  9. UNDER NO CIRCUMSTANCE IS THE CONTRACTOR TO DISRUPT ANY OPERATIONS AT THE SITE HOST
  LOCATION, INCLUDING BUT NOT LIMITED TO CUSTOMER DISRUPTION, UTILITIES, AND INFRASTRUCTURE.

  10. CONTRACTOR SHALL BE RESPONSIBLE TO PROTECT WORK AREAS WITH CONES AND/OR BARRICADES AT
  ALL TIMES.

#### **EROSION CONTROL & GRADING NOTES:**

- ADDITIONAL EROSION CONTROL DEVICES TO BE USED AS REQUIRED BY LOCAL INSPECTOR.
  DISTURBED AREAS LEFT IDLE FOR FIVE DAYS, AND NOT TO FINAL GRADE, WILL BE ESTABLISHED TO
  TEMPORARY VEGETATION, MULCH, TEMPORARY VEGETATION OR PERMANENT VEGETATION SHALL BE
  COMPLETED ON ALL EXPOSED AREAS WITHIN 14 DAYS AFTER DISTURBANCE, ALL AREAS TO FINAL GRADE
  WILL BE ESTABLISHED TO PERMANENT VEGETATION UPON COMPLETION.
  WHEN HAND PLANTING, MULCH (HAY OR STRAW) SHOULD BE UNIFORMLY SPREAD OVER SEEDED AREA
  WITHIN 24 HOURS OF SEEDING, IF UNABLE TO ACCOMPLISH, MULCH SHALL BE USED AS A TEMPORARY
  COVER, CONCENTRATED FLOW AREAS AND ALL SLOPES STEEPER THAN 2.5:1 AND WITH A HEIGHT OF TEN
  FEET OR GREATER (DOES NOT APPLY TO RETAINING WALLS), AND CUTS AND FILLS WITHIN BUFFERS,
  SHALL BE STABILIZED WITH THE APPROPRIATE EROSION CONTROL MATTING OR BLANKETS.
  THE ESCAPE OF SEDIMENT FROM THE SITE SHALL BE PREVENTED BY THE INSTALLATION OF EROSION
  AND SEDIMENT CONTROL MEASURES AND PRACTICES PRIOR TO, OR CONCURRENT WITH,
  LAND-DISTURBING ACTIVITIES.
- LAND-DISTURBING ACTIVITIES. EROSION CONTROL MEASURES WILL BE MAINTAINED AT ALL TIMES. IF FULL IMPLEMENTATION OF THE
- PLAN DOES NOT PROVIDE FOR EFFECTIVE EROSION CONTROL, ADDITIONAL EROSION CONTROL AT SEDIMENT CONTROL MEASURES SHALL BE IMPLEMENTED TO CONTROL OR TREAT THE SEDIMENT
- SEED ALL DISTURBED AREAS UNLESS OTHERWISE NOTED AS PART OF THIS CONTRACT
- 6. SEED ALL DISTURBED AREAS UNLESS OTHERWISE NOTED AS PART OF THIS CONTRACT.
  7. THE CONTRACTOR SHALL DETERMINE THE EXACT LOCATION OF ALL EXISTING UTILITIES BEFORE COMMENCING WORK AND AGREES TO BE RESPONSIBLE FOR ANY AND ALL EXISTING UTILITIES BEFORE RESULT FROM THE CONTRACTOR'S FAILURE TO EXACTLY LOCATE AND PRESERVE ANY UNDERGROUND UTILITIES TO REMAIN. THE CONTRACTOR IS TO NOTIFY ENSINEER IMMEDIATELY OF ANY DISCREPANCIES ANDIOR CONFLICTS WITH EXISTING OR PROPOSED UTILITIES PRIOR TO PROCEEDING.
  8. STOCKPILED TOPSOLI OR FILL MATERIAL, IS TO BE TREATED SO THE SEDIMENT RUN-OFF WILL NOT CONTAMINATE SURROUNDING AREAS OR ENTER NEARBY STREAMS. STOCK PILE LOCATIONS SHALL BE COORDINATED WITH THE ENGINEER PRIOR TO GRADING ACTIVITIES. EROSION & SEDIMENT CONTROL PRACTICE SHALL BE INSTALLED PRIOR TO STOCKPILE OPERATIONS.
  9. CONSTRUCT SILT BARRIERS BEFORE BEGINNING GRADING OPERATIONS.
  10. MULCH AND SEED ALL DISTURBED AREAS AS SOON AS POSSIBLE AFTER FINAL GRADING IS COMPLETED (WITHIN 15 DAYS OF ACHIEVED FINAL GRADES) UNLESS OTHERWISE INDICATED. CONTRACTOR SHALL TAKE WHATEVER MEANS NECESSARY TO ESTABLISH PERMANENT SOIL STABILIZATION. STEEP SLOPES (GREATER THAN 3:1) SHALL BE STABILIZED WITHIN 7 DAYS OF FINAL GRADING.
  12. DO NOT DISTURB VEGETATION OR REMOVE TREES EXCEPT WHEN NECESSARY FOR GRADING.

### ADA COMPLIANCE:

- CURB RAMPS ALONG PUBLIC STREETS AND IN THE PUBLIC RIGHT-OF-WAY SHALL BE CONSTRUCTED
- BASED ON THE CITY STANDARD CONSTRUCTION DETAILS AND SPECIFICATIONS. PRIVATE CURB RAMPS ON THE SITE (I.E. OUTSIDE PUBLIC STREET RIGHT-OF-WAY) SHALL CONFORM TO
- ADA STANDARDS AND SHALL HAVE A DETECTABLE WARNING SURFACE THAT IS FULL WIDTH AND FULL DEPTH OF THE CURB RAMP, NOT INCLUDING FLARES.
- DEPTH OF THE CURB RAMP, NOT INCLUDING FLARES.
  ALL ACCESSIBLE ROUTES, GENERAL SITE AND BUILDING ELEMENTS, RAMPS, CURB RAMPS, STRIPING, AND
  PAVEMENT MARKINGS SHALL CONFORM TO ADA STANDARDS FOR ACCESSIBLE DESIGN, LATEST EDITION.
  BEFORE PLACING PAVEMENT, CONTRACTOR SHALL VERIFY THAT SUITABLE ACCESSIBLE PEDESTRIAN
- ROUTES (PER ADA AND FHA) EXIST TO AND FROM EVERY DOOR AND ALONG SIDEWALKS. ACCESSIBLE
- ROUTES (PER ADA AND FHA) EXIST TO AND FROM EVERY DOOR AND ALONG SIDEWALKS, ACCESSIBLE PARKING SPACES, ACCESS ASLES, AND ACCESSIBLE ROUTES. IN NO CASE SHALL AN ACCESSIBLE RAMP SLOPE EXCEED 1 VERTICAL TO 12 HORIZONTAL. IN NO CASE SHALL SIDEWALK CROSS SLOPE EXCEED 2.0 PERCENT. IN NO CASE SHALL LONGITUDINAL SIDEWALK SLOPE EXCEED 5.0 PERCENT. ACCESSIBLE PARKING SPACES AND ACCESS AISLES SHALL NOT EXCEED 2.0 PERCENT SLOPE IN ANY DIRECTION. CONTRACTOR SHALL TAKE FIELD SLOPE MEASUREMENTS ON FINISHED SUBGRADE AND FORM BOARDS PRIOR TO PLACING PAVEMENT TO VERIFY THAT ADA SLOPE REQUIREMENTS ARE PROVIDED. CONTRACTOR SHALL CONTACT ENGINEER PRIOR TO PAVING IF ANY EXCESSIVE SLOPES ARE ENCOUNTERED. NO CONTRACTOR CHANGE ORDERS WILL BE ACCEPTED FOR ADA SLOPE COMPLIANCE ISSUES.

#### SITE NOTES:

- 1. HORIZONTAL DIRECTIONAL DRILLING (HDD) OR OTHER TRENCHLESS METHODS AS APPROVED BY SITE HOST ARE THE PREFERRED METHOD TO INSTALL CONDUIT BENEATH EXISTING PARKING LOTS AND PAVED
- CONDUIT SHALL BE INSTALLED AT A MINIMUM DEPTH OF TWO AND ONE-HALF FEET (2.5') OR BELOW THE FREEZE LINE, WHICHEVER IS DEEPER. CONDUIT TYPE AND DESIGN TO BE SPECIFIED BY EV CHARGING STATION VENDOR AND MEET ALL LOCAL REQUIREMENTS. CONDUIT DIAMETER SHALL BE
- CHARGING STATION VENDOR AND MEET ALL LOCAL REQUIREMENTS, CONDUIT DIAMETER SHALL BE NO LARGER THAN TWO (2) INCHES.

  THE RECEIVING PIT SHALL BE LOCATED AS CLOSE AS REASONABLY POSSIBLE TO THE PROPOSED WALL PENETRATION TO LIMIT THE LENGTH OF BUILDING-MOUNTED CONDUIT, LOCATE RECEIVING PIT WITHIN ASPHALT PAVED AREA OR CONCRETE SIDEWALK AREA, RECEIVING PIT SHALL NOT BE LOCATED WITHIN THE UNLCADING PAD [SIX TO TEN INCH (6-10) REINFORCED CONCRETE SLAB AT THE REAR OF THE STORE], RECEIVING PIT LOCATION AND WORK AREA SHALL NOT AFFECT SITE HOST CUSTOMER OR DELIVERY TRAFFIC. SEE SUPPLEMENTAL DOCUMENTS, RECEIVING AREA DIAGRAM. THE RECEIVING PIT SIZE SHALL BE LIMITED TO THERE FEET (3) BY THREE FEET (3) AND SHALL NOT AND AND SHALL NOT UNDERMINE THE BUILDING FOUNDATION, ENCLOSURES OR CONCRETE UNLCADING PAD. BACKFILL EXCAVATIONS AND REPAIR PAVEMENT PER SPECIFICATIONS BELOW. WHERE CONCRETE PAVEMENT, SIDEWALK, ASPHALT PAVEMENT, CURBING, OR CURBING GUTTER IS REMOVED, THE WIDTH OF THE REMOVED, SHALL WOTH AT THE TOP OF THE
- REMOVED, THE WIDTH OF THE REMOVAL SHALL EXCEED THE ACTUAL WIDTH AT THE TOP OF THE TRENCH BY TWELVE INCHES (12") ON EACH SIDE OF THE TRENCH, OR A TOTAL OF TWO FEET (2')
- WIDER THAN THE TRENCH.
  TRENCHING THROUGH THE CONCRETE RECEIVING PAD AT THE REAR OF THE STORE OR THE DRIVE-THRU SLAB IS NOT ALLOWED. ONLY TRENCHING THROUGH MINOR CONCRETE INSTALLATIONS SUCH AS SIDEWALKS WILL BE PERMITTED.
- EXCAVATE TRENCHES TO A DEPTH FOUR INCHES (4") DEEPER THAN BOTTOM OF FINISHED PIPE
- ELEVATION. THE BOTTOM WIDTH OF THE TRENCH SHALL BE AS REQUIRED TO PERMIT CONDUIT TO BE PROPERLY AIN AND BACKELL TO BE PLACED AND PROPERLY COMPACTED
- REMOVED PAVEMENT, CONCRETE AND EXCAVATED MATERIALS UNSUITABLE FOR USE AS BACKFILL SHALL BE DISPOSED OFFSITE. BEDDING AND BACKFILL MAY BE MATERIAL EXCAVATED FROM THE TRENCH PROVIDED THAT IT IS FREE

- BEDDING AND BACKFILL MAY BE MATERIAL EXCAVATED FROM THE TRENCH PROVIDED THAT IT IS FREI FROM DEBRIS AND ROCKS LARGER THAN ONE AND ONE-HALF INCHES (1-1/2').

  OVER THE PIPE, IN LAYERS NOT EXCEEDING FOUR INCHES (4'), PLACE AND COMPACT SUITABLE FILL MATERIAL TO NINETY-FIVE PERCENT (95%) DRY DENSITY AS DETERMINED BY ASTM D598.

  COMPACTING EQUIPMENT SHALL BE OF SUCH DESIGN, WEIGHT, AND QUALITY AS IS REQUIRED TO OBTAIN THE DENSITIES SPECIFIED HEREIN OR INDICATED ON THE DESIGN DRAWINGS. AREAS INACCESSIBLE TO SELF-PROPELLED COMPACTING EQUIPMENT SHALL BE COMPACTED OR CONSOLIDATED BY HAND-OPERATED MECHANICAL TAMPERS OR VIBRATORS.

  RESTORE GRASS, LANDSCAPING, IRRIGATION AND ALL FEATURES TO THEIR PRECONSTRUCTION CONDITION.

- 2. ANY UTILITIES, PAVEMENT, IRRIGATION, LANDSCAPING OR OTHER SITE FEATURES DAMAGED DURING
  CONSTRUCTION SHALL BE REPAIRED BY EV CHARGING STATION VENDOR TO SITE HOST SPECIFICATION.
  2.1. WHERE LANDSCAPING IS IMPACTED, IT IS THE RESPONSIBILITY OF EV CHARGING STATION VENDOR TO
  REPOSITION OR PROVIDE NEW LANDSCAPING WITHIN THE SITE HOST PROPERTY TO ENSURE
- COMPLIANCE WITH ANY CODE REQUIREMENTS.
  WHERE PARKING LOT, SIDEWALK OR OTHER PAVED AREAS ARE IMPACTED OR DAMAGED, IT IS THE RESPONSIBILITY OF THE EV CHARGING STATION VENDOR TO REPAIR THE AREA TO LIKE NEW CONDITION, REPAIR SHOULD EXTEND BEYOND DAMAGED AREA TO NEAREST CLEAN BREAK THAT
- ALIGNS WITH ARCHITECTURAL BREAKS, MATERIAL JOINTS, PAVEMENT MARKINGS, ETC.

  3. WHERE APPLICABLE. UTILITY SERVICE PROVIDER TO USE SITE HOST APPROVED ROE (RIGHT OF ENTRY).
- ALLIGISS WITH ARCHITELUTRAL BREAKS, WAI ENALS, JOINIS, PAVEMENT MARKHINES, ETC.

  3. WHERE APPLICABLE, UTILITY SERVICE PROVIDER TO USE SITE HOST APPROVED ROE (RIGHT OF ENTRY)
  AGREEMENT, SITE HOST PROGRAM MANAGER WILL PROVIDE TEMPLATE WHEN NECESSARY.

  4. ASPHALT PAVEMENT REMOVAL AND REPLACEMENT

  4.1. SAW CUT THE PAVEMENT TO NEAT, STRAIGHT LINES TO THE FULL DEPTH OF THE PAVEMENT.
  PAVEMENT REMOVAL SHALL EXTEND A MINIMUM OF TWELVE INCHES (12') BEYOND THE EDGES OF THE
  REMOVAL AREA. ANY OTHER PAVEMENT AREAS DAMAGED DURING REMOVAL SHALL ALSO BE
  REPAIRED OR REPLACED AS NECESSARY

  4.2. REMOVE THE PAVEMENT WITHOUT DAMAGING THE PAVEMENT THAT IS TO REMAIN IN-PLACE.

  4.3. IF BASE REPLACEMENT IS REQUIRED, COMPACT THE IN-SITU SOILS TO NINETY-PIVE PERCENT (95'%)
  ASTM D698 AND PLUS OR MINUS TWO PERCENT (2%) OF OPTIMUM MOISTURE CONTENT. REMOVE AND
  REPLACE ANY UNSUITABLE IN-SITU SOILS.

  4.4. PLACE AND COMPACT BASE MATERIAL TO NINETY-FIVE PERCENT (95%) OF ASTM D698.

  4.5. APPLY PRIME COAT TO AGGREGATE BASE IN COMPLIANCE WITH THE DOT SPECS. PRIME COAT SHALL
  NOT BE APPLIED MORE THAN TWENTY-FOUR (24) HOURS BEFORE ASPHALT PAVEMENT IS PLACED.

  APPLICATION RATE TO BE PER THE DOT SPEC.

  4.6. CLEAN AND APPLY TACK COAT TO THE ENDS OF CURBS, EDGES OF CONCRETE SURRACES, EDGES OF
  MANHOLES AND INLETS AND EDGES OF SAW CUT PAVEMENT THAT WILL REMAIN IN-PLACE.

  4.7. PLACE AND COMPACT HOT-MIX ASPHALT. HOT-MIX ASPHALT THICKNESS SHALL BE THE GREATER OF
  THE IN-PLACE ASPHALT OR THREE AND ONE-HALF INCHES (3.5'). ASPHALT MIX DESIGNS SHALL BE BY


- THE IN-PLACE ASPHALT OR THREE AND ONE-HALF INCHES (3,5"). ASPHALT MIX DESIGN SHALL BE BY PLANT MIXED ASPHALT BASE/BINDER COURSE: PROVIDE ONE COURSE LAID TO A MINIMUM
- COMPACTED THICKNESS OF TWO INCHES (2").
  4.9. PLANT MIXED ASPHALT SURFACE COURSE: PROVIDE ONE COURSE LAID TO A MINIMUM COMPACTED
- THICKNESS OF ONE AND ONE-HALF INCHES (1-1/2").
  FOR SMALLER JOBS, IT MAY NOT BE FEASIBLE TO INSTALL BINDER AND SURFACE COURSES, IN WHICH
- CASE SURFACE COURSE, PLACED AND COMPACTED IN TWO LIFTS, WILL BE ACCEPTED, IN WILL OF PLACED AND COMPACTED IN TWO LIFTS, WILL BE ACCEPTED SOFT THE PLACED AND COMPACTED IN TWO LIFTS, WILL BE ACCEPTED SOFT THE PATCH AND WORKING INWARD, HMA SHOULD NOT BE PLACED IN THE CENTER OF THE PATCH AND
- RAKED TOWARDS THE EDGES.

  THE FIRST PASS OF THE ROLLER OR COMPACTION EQUIPMENT SHOULD BE ALONG THE EDGES OF THE PATCH TO PROPERLY FORM THE JOINT. THE ROLLER WHEEL OR COMPACTION EQUIPMENT SHOULD OVERHANG THE EXISTING PAVEMENT ONTO THE PATCH BY SIX INCHES (6°). AFTER THE PERIMETER OF THE PATCH HAS BEEN COMPACTED BEGIN TO WORK TOWARDS THE CENTER OF THE PATCH WITH SUCCESSIVE PASSES OFFSET BY SIX INCHES (6°).

  THE CONTRACTOR SHALL UTILIZE THE APPROPRIATE HEAVY COMPACTION EQUIPMENT TO ACHIEVE THE REQUIRED COMPACTION OF THE ASPHALT.

  SEAL THE AREA AROUND THE EDGES WITH AN ELASTOMERIC LIQUID ASPHALT SEALER TO PROTECT AGAINST WATER INFILTRATION, INCLUDING ANY INADVERTENT OVERCUTS DURING THE SAW CUTTING PROCEDURE.

## PROJECT LEGEND:

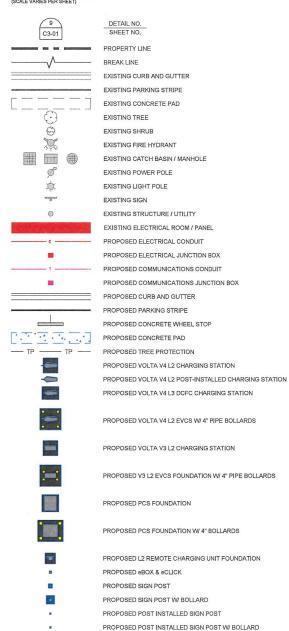

PROPOSED WALL MOUNTED SIGN

PROPOSED 4" ISOLATED PIPE BOLLARD



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**STOP & SHOP #2702** CRANSTON

**275 WARWICK AVENUE CRANSTON, RI 02905** 

SHEET TITLE

**GENERAL NOTES** 

SHEET NUMBER

CO-01



## **Volta Gen4 L2 Station**

Volta provides turn-key Electric Vehicle (EV) charging services for premium retail and entertainment destinations. We install and maintain the charging amenity at no cost to site partners as well as EV drivers, driving increased property value and attracting more customers who stay longer.

## **VOLTA STATION BENEFITS**

- · Installation, equipment and maintenance is paid by Volta
- · Charges all electric vehicles
- Free electricity supported through third party content on displays
- · Volta stations are occupied 80% of the retail day
- Volta has provided 88M free sponsored electric miles, delivered 25 gigawatt hours and eliminated over 39M pounds of CO2 emissions

## CHARGING UNIT INFORMATION (Single Charging Units)

- Size: H 85.0" x W 36.5" x D 15.5"
- Display Size: H 48" x W 27
- Power Type: 208/240VAC, 48A, 10kW max; UL 2202
- · Plug: SAE J1772 compliant connector

## POWER REQUIREMENTS

volta

- · Charging unit: 60A/2P, 208/240 breaker
- Display/connectivity: 20A/1P, 120V

## breaker INSTALLATION REQUIREMENTS

- · Wire Diameter: #6 AWG minimum. Larger for longer conduit runs
- Conduit Diameter: 1.5" minimum per station. Larger conduit required for runs over 250'



55" Media Display

Charges up to 30miles per hour

Universal J1772 connections

Cable Management

Fully Networked

Proprietary & Confidential - Do Not Distribute





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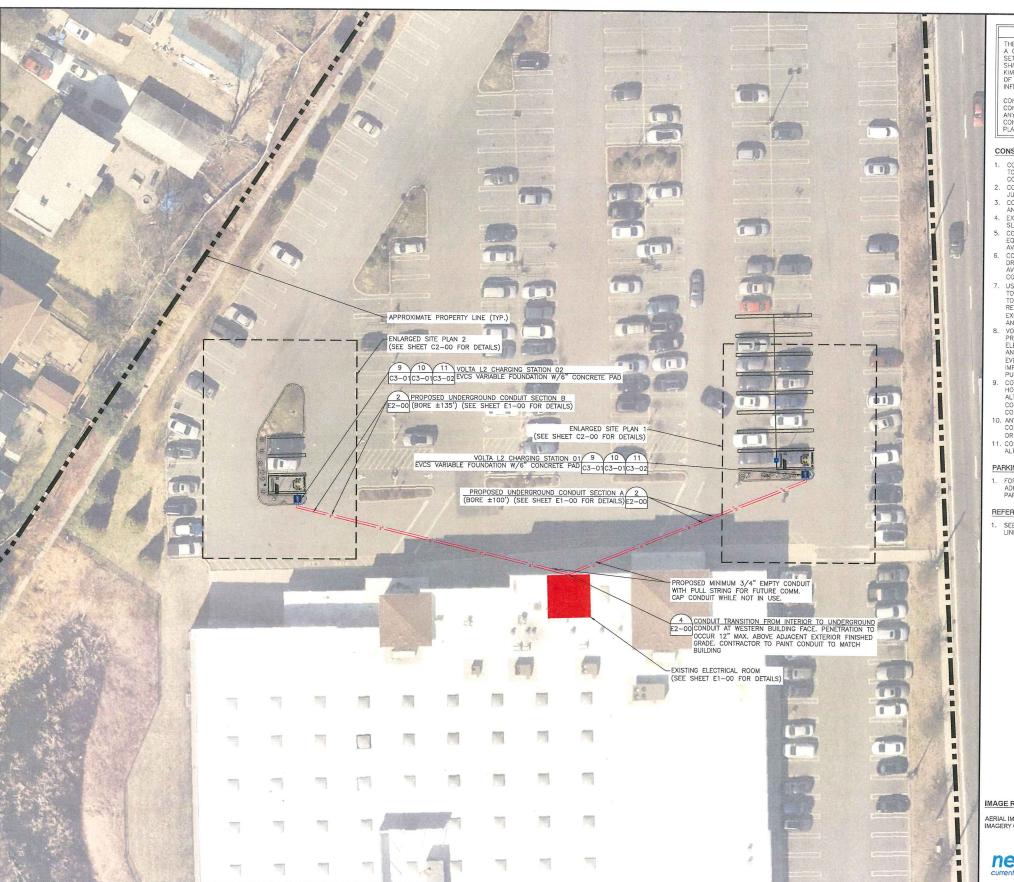
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SHEET TITI

VOLTA STATION OVERVIEW

SHEET NUMBE

C0-02



**OVERALL SITE PLAN** 

#### DISCLAIMER

THESE DRAWINGS WERE PRODUCED WITHOUT THE BENEFIT OF A CURRENT LAND SURVEY, ALL PROPERTY LINES, EASEMENTS, SETBACKS, EXISTING INFRASTRUCTURE AND TITLE DOCUMENTS SHALL BE VERIFIED PRIOR TO START OF CONSTRUCTION. KIMLEY-HORN AND VOLTA DO NOT GUARANTEE THE ACCURACY OF SAID PROPERTY LINES, EASEMENTS, SETBACKS, EXISTING INFRASTRUCTURE AND TITLE DOCUMENTS.

CONTRACTOR IS RESPONSIBLE FOR VERIFYING ALL FIELD CONDITIONS AND IS TO ALERT THE ENGINEER AND VOLTA OF ANY DISCREPANCIES PRIOR TO STARTING CONSTRUCTION. CONTRACTOR TO COORDINATE WITH VOLTA PM FOR ALL FINAL PLACEMENTS OF INFRASTRUCTURE.

#### CONSTRUCTION NOTES:

- CONTRACTOR RESPONSIBILITIES CONSISTS OF, BUT NOT LIMITED TO, CHARGING STATION MOUNTING, FOUNDATION CONSTRUCTION, CONDUIT INSTALLATION, AND WIRING.
- CONDUIT INSTALLATION, AND WIRING.

  2. CONTRACTOR TO PAINT PROPOSED EV PARKING SPACES PER JURISDICTIONAL REQUIREMENTS.

  3. CONTRACTOR TO INSTALL TREE PROTECTION FENCING PRIOR TO ANY CONSTRUCTION ACTIVITY. SEE SHEET C3—00 FOR DETAILS.

  4. EXACT STATION PLACEMENT AND ROTATION ANGLE MAY VARY SLIGHTLY UPON INSTALLATION DEPENDING ON SITE CONDITIONS.

  5. CONTRACTOR TO FIELD VERIETY ALL STALL DIMENSIONS AND ALL EQUIPMENT LOCATIONS TO ENSURE SUFFICIENT SPACE IS AVAILABLE.
- AVAILABLE.
- CONTRACTOR SHALL TAKE NECESSARY PRECAUTIONS WHEN DRILLING INTO EXISTING CIP SLAB AND CIP DROP PANELS TO AVOID DAMAGE TO ANY REINFORCING AND EXISTING STRUCTURAL COMPONENTS.
- COMPONENTS.

  7. USE APPROVED ASTM METHOD (X-RAY, PACOMETER, GPR, ETC.)

  TO LOCATE MILD STEEL AND PRE-STRESSING TENDONS PRIOR
  TO DRILLING, DO NOT CUT OR DRILL THROUGH ANY EXISTING
  REINFORCING. ADJUST LOCATION AS NECESSARY TO AVOID
  EXISTING REINFORCING, ENSURE 1" GAP MIN. BETWEEN REBAR
  AND ANCHORAGE.

  3. VOLTA WILL MAKE EVERY EFFORT TO FOLLOW, WITH THEIR
  PROPOSED CONDUIT, AN EXISTING CONDUIT ROUTE FROM
  ELECTRICAL ROOM TO PROPOSED STATION PLACEMENTS. WHEN
  AN EXISTING ROUTE IS NOT AVAILABLE, VOLTA WILL MAKE
  EVERY EFFORT TO CONCEAL/HIDE, PAINT AND MINIMIZE VISUAL
  IMPACT OF CONDUITS ANYWHERE THEY MAY BE VISIBLE TO THE
  PUBLIC.
- PUBLIC.

  CONTRACTOR IS RESPONSIBLE TO LOCATE ALL VERTICAL AND HORIZONTAL UTILITIES PRIOR TO DIRECTIONAL BORING, ANY ALTERATIONS TO THE PROPOSED CONDUIT ROUTE ARE TO BE COORDINATED WITH THE PROFESSIONAL ENGINEER(S) PRIOR TO
- COURDINATED WITH THE PROFESSIONAL ENGINEER(S) PRIOR TO CONSTRUCTION.

  10. ANY ITEMS TO REMAIN THAT ARE DAMAGED BY THE CONTRACTOR SHALL BE REPLACED TO THE EXISTING CONDITION OR BETTER AT THE CONTRACTOR'S EXPENSE.

  11. CONTRACTOR TO LOCATE JUNCTION BOX OR APPROVED ALTERNATIVE FOR SITE SPECIFIC RUN LENGTHS AND BENDS.

FOR THE PURPOSE OF THIS PLAN IT IS ASSUMED THERE IS ADEQUATE PARKING IN EXISTING CONDITIONS TO CONVERT 2 PARKING SPACES TO 2 EV PARKING SPACES.

SEE PROJECT LEGEND ON SHEET CO-01 FOR SYMBOLS AND LINE TYPE DESCRIPTIONS.



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SHEET TITLE

**OVERALL SITE PLAN** 


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IMAGE REFERENCE:







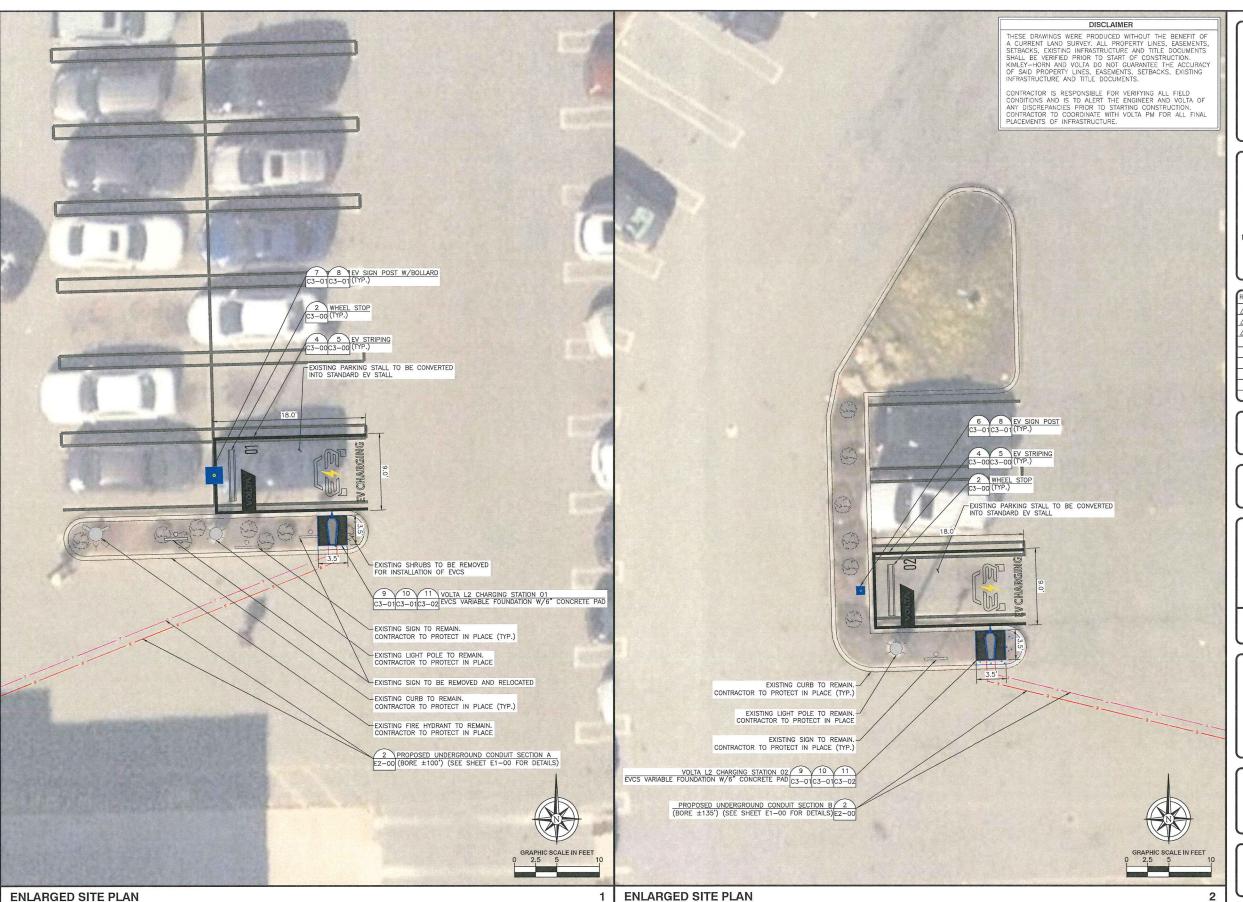

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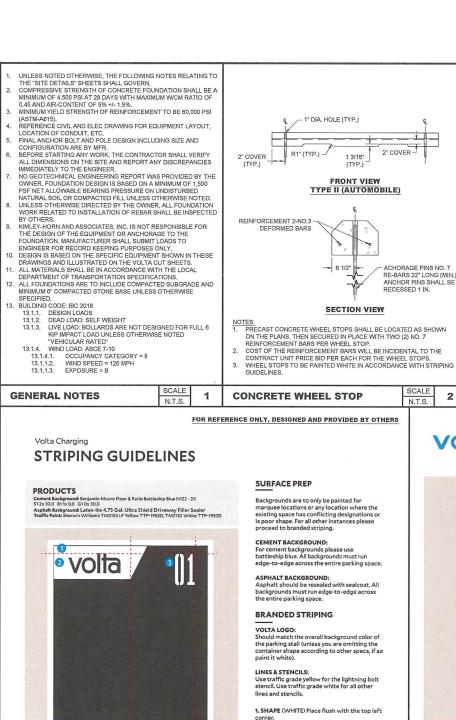
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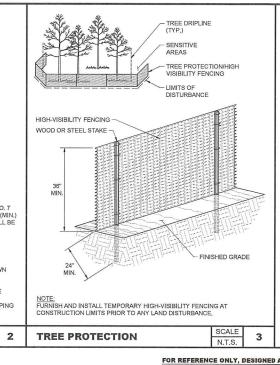
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ENLARGED SITE PLAN

SHEET NUMBER

C2-00






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# ABSOLUTELY DO NOT

STRIPING BEST PRACTICES

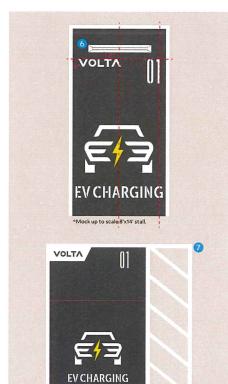

VOLTA

 Paint only a portion of the background (edge-to-edge or not at all) Paint the lightning bolt, any color but yellow or white Break EV CHARGING into 2 lines . Only put 1 number in top right corner

Paint the Volta logo any color other than white or Battleship Blue/Sealcoat

### ACCESSORIES

**6. WHEEL BLOCKS** Place 8 inches above the Volta logo, centered within the stall. Wheel Blocks should be painted white.

7. ACCESS AISLE Should be painted white.

CURBS No need to paint the curbs unless the are painted an existing or conflicting color. If this is the case, paint the curb white.



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**275 WARWICK AVENUE CRANSTON, RI 02905** 

SHEET TITLE

SITE DETAILS

SHEET NUMBER

C3-00

Founded in 2010. Designed in San Francisco, built to last in the USA.

SCALE **EV STRIPING GUIDELINES** 4

2. VOLTA LOGO Center within the shape.

3. NUMBERS (WHITE) The right number lines up flush right to the "G" in "CHARGING" and flush top with the Volta logo. There should be 3 inches in-between the left and right numbers. If stall is less than 8 feet, align numbers with the middle of the "G" (See page 2).

4. LETTERS Place centered, 4 inches from the bottom of the stall.

5. CAR Place centered 14 inches from the top

1 of 3

**EV STRIPING GUIDELINES** 

N.T.S.


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**SEV CHARGING** 

volta

SCALE 5

2 of 3

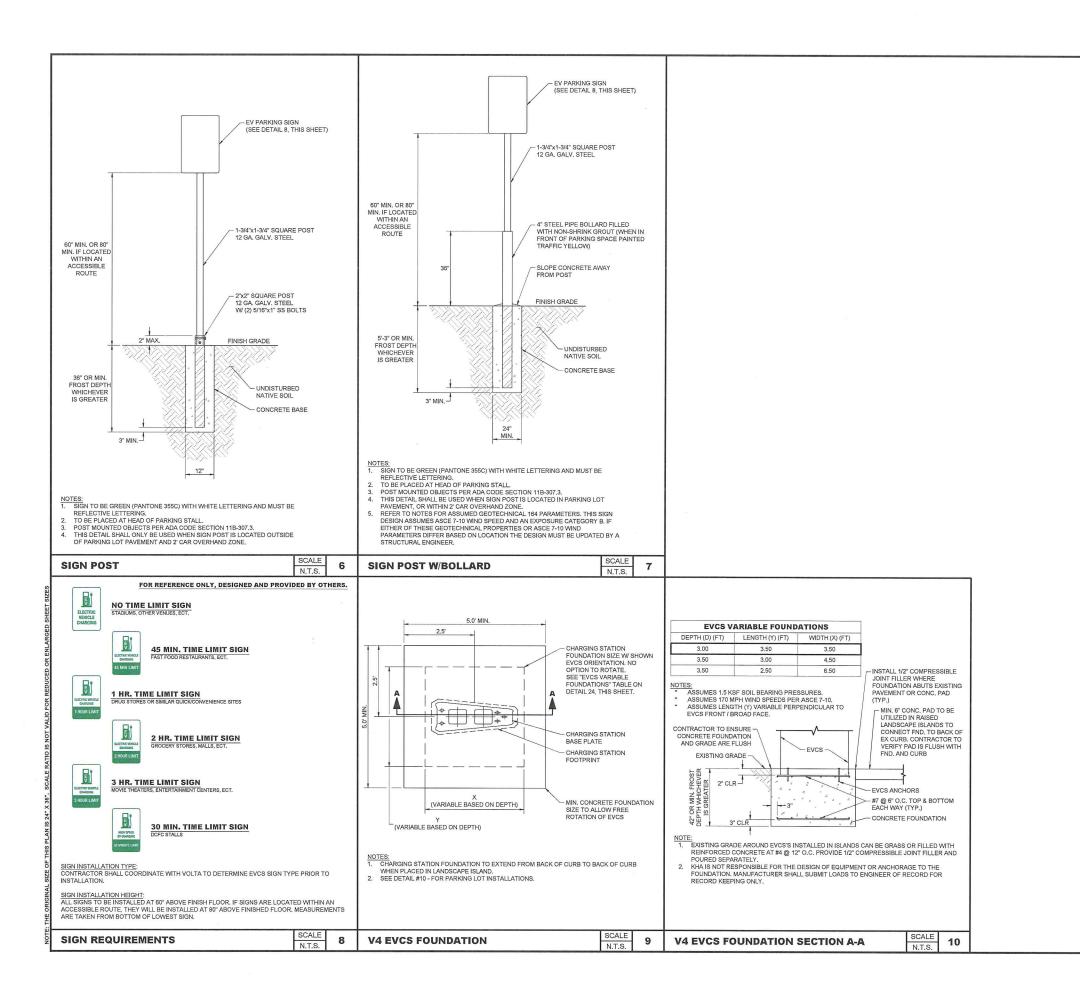

# VOLTA

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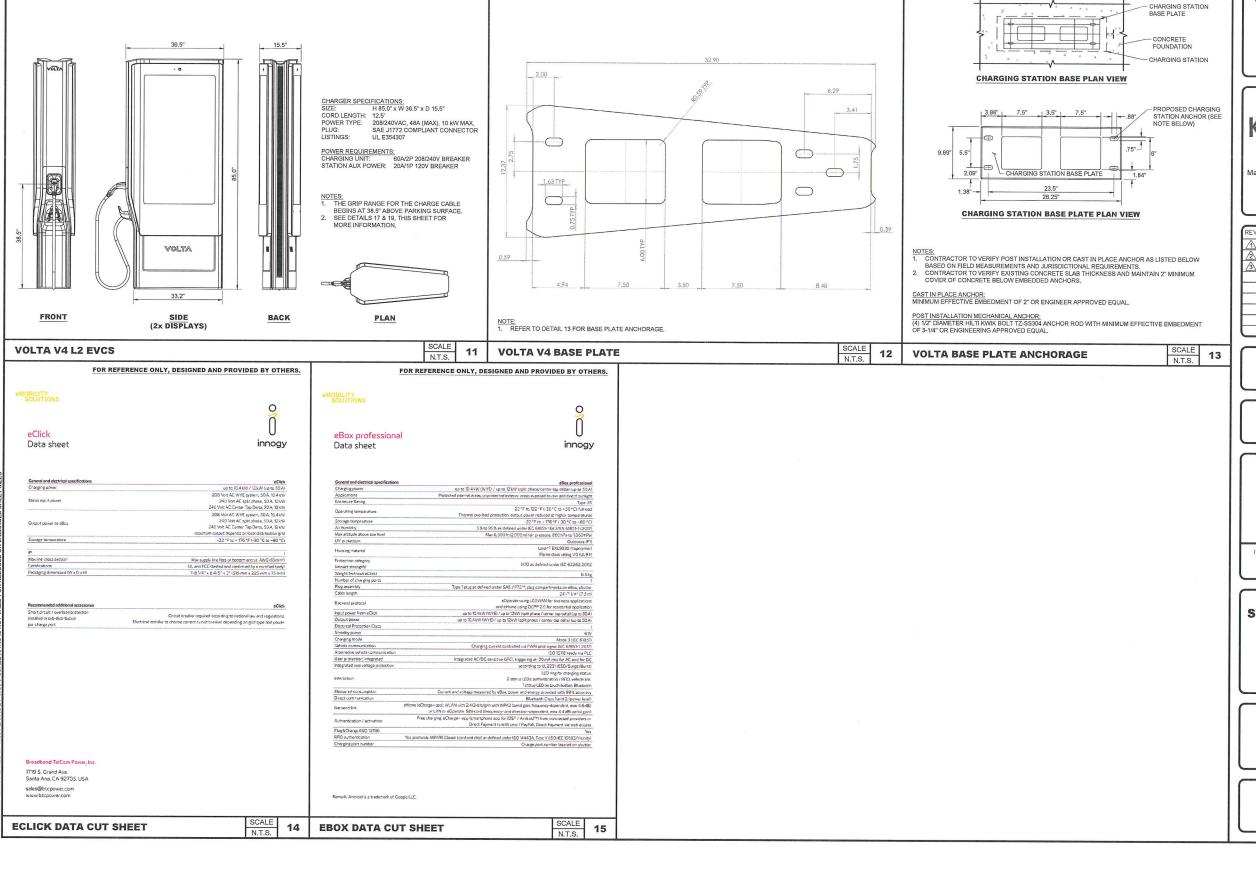
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SITE DETAILS

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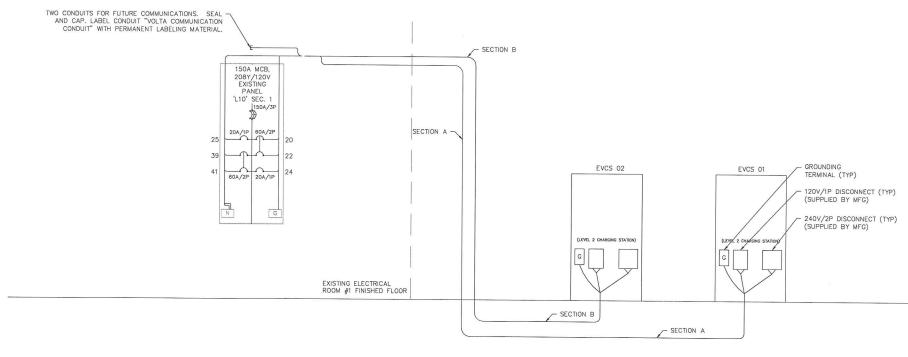
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SITE DETAILS

SHEET NUMB

C3-02





EXISTING ELECTRICAL PANEL 'L10' SECTION 1

#### NOTES:

- 1. ALL ELECTRICAL WORK AND RELATED ACTIVITIES PERFORMED ON SITE SHALL BE DONE IN ACCORDANCE WITH NATIONAL ELECTRICAL CODE (NEC) STANDARDS BEING ENFORCED BY ALL APPLICABLE JURISDICTIONAL REQUIREMENTS AT THE TIME OF CONSTRUCTION.
- 2. ANY PAVEMENT DAMAGED DURING CONSTRUCTION SHALL BE REPAIRED OR REPLACED BY THE CONTRACTOR TO PRE-CONSTRUCTION CONDITIONS OR BETTER.
- 3. CONTRACTOR SHALL USE THWN COPPER CONDUCTORS.
- 4. CONTRACTOR SHALL USE EMT INSIDE AND OUTSIDE ABOVE GRADE WHERE NOT SUBJECT TO DAMAGE. CONTRACTOR SHALL RGS INSIDE AND OUTSIDE ABOVE GRADE WHERE SUBJECT TO DAMAGE. CONTRACTOR SHALL USE PVC SCHEDULE 80 BELOW GRADE.
- 5. SEE SHEETS C1-00 AND C2-00 FOR CONDUIT STUB UP LOCATIONS.
- 6. CONTRACTOR TO LOCATE JUNCTION BOX, CONDUIT PULLING POINTS, OR APPROVED ALTERNATIVE FOR SITE SPECIFIC RUN LENGTHS AND BENDS.
- 7. THE CONTRACTOR SHALL PERFORM A 30-DAY LOAD STUDY ON PANEL 'L10' SECTION 1. THE LOAD STUDY SHALL UTILIZE A METERING DEVICE THAT CAN MEASURE AND RECORD THE PEAK DEMAND ON EACH PHASE CONDUCTOR AND THE NEUTRAL CONDUCTOR EVERY 15 MINUTES OVER THE DURATION OF THE 30-DAY PERIOD. THE RESULTS SHALL BE SUBMITTED TO THE ENGINEER FOR APPROVAL EITHER IN .XLSX FORMAT WITH DATE, TIME, PHASE COLUMNS AND RECORDED PEAK DEMAND OR IN PLOTTED FORMAT FOR EACH PHASE AND NEUTRAL WITH AMPS SHOWN ON THE Y-AXIS. ON THE AXIS. ON THE RESULTS SUBMITTAL, INCLUDE THE NAME OF THE ELECTRICIAN, THE DAYS THE LOAD STUDY STARTED AND FINISHED, AND THE NAME OF THE PANEL THAT THE LOAD STUDY IS BEING PERFORMED ON. THE CONTRACTOR SHALL NOT PROCEED WITH ANY MODIFICATIONS AND/OR ADDITIONS UNTIL WRITTEN APPROVAL IS RENDERED FROM THE ENGINEER.

		Existing Pa	anel 'L10' SECT	TION 1	ocation: E		Panel Sch ectrical Ro		olts: 208	Y/120V	Phase:	Wire: 4	Hertz: 60		
			150A MC	B Main	AIC: N/A	Branch /	NC: (See I	Note 3) E	NCL. (NE			Surface	110102. 00		
					150 Amp Fr				ver, Pane	el Card.		0411400			
Description of Load Served	E	reaker	Wire	A/Phase						A/Phase	1	300	Breaker		
310-2010/00 • 000 000 N200 H000 H00 H000 N400 N4	Amp	Pole	vviie	Α	В	С	CKI No.	CKT No.	Α	В	C	Wire	Amp	Pole	Description of Load Served
REGISTER #1	20	1	EXIST	EX			1	2	EX			EXIST	20	1	REGISTER #2
REGISTER #3	20	1	EXIST		EX		3	4		EX		EXIST	20	1	REGISTER #4
REGISTER #5	20	1	EXIST			EX	5	6			FX	EXIST	20	1	REGISTER #6
REGISTER #7	20	1	EXIST	EX			7	8	EX		-	EXIST	20	1	REGISTER #8
REGISTER #9	20	1	EXIST		EX		9	10		EX	_	EXIST	20	1	REGISTER #10
REGISTER #11	20	1	EXIST			EX	11			LA	EX	EXIST	20	1	REGISTER #10
REGISTER #13	20	1	EXIST	EX			13		EX		LA	EXIST	20	-	REGISTER #14
REGISTER SPARE	20	1	EXIST		EX		15		LA		-	LANI	20	1	SPARE
SUB PANEL				J. Links		EX	17				-		20	-	
SUB PANEL	40	3	EXIST	EX		LA	19		48,0		-	_	20	2	SPARE
SUB PANEL				m/ C	EX		21		40.0	48.0		See Note 5	60		CHARGING STATION EV02
SPARE	20	1	EXIST				23			40.0	5.0	See Note 5	20	1	011150110 0515151
CHARGING STATION EV01	20	1	See Note 5	5.0			25		EX		5.0	EXIST	20	1	CHARGING STATION EV02
POS COMP RACK FANS	20	1	EXIST		EX		27		LA	EX	-	EXIST	20	1	ELEV PIT SUMP PUMP
ISP COMP RACK FANS	20	1	EXIST			EX	29			EV	EX	EXIST	20	1	ELEV PIT LTG/RECEPT
POS ROOM RECEPT	20	1	EXIST	EX	_	LA	31		EX		EX	EXIST		1	VESTIBULE RECEPT
EWC RECEPT	20	1	EXIST	LA	EX	_	33		EV	EX	_	EXIST	20	1	EXTERIOR RECEPT
ELECT CART RECPT	20	1	EXIST	_	LA	EX	35		_	EX	- FW	EXIST	20	1	HP TOILET EMERG CALL
ELECT CART RECPT	20	1	EXIST	EX		EA	37		EX		EX	EXIST	20	2	MENS HAND DRYER
CHARGING STATION EV01	60	-			48.0		39		LA	FX					TOTAL STATE OF THE
CHARGING STATION EVVI	60	2	See Note 5			48.0	41			LX	EX	EXIST	20	2	WOMENS HAND DRYER
	Tota	A/Phase		5.0	48.0	48.0			48.0	48.0	5.0		Total A	Phase	
tes:	<ol> <li>Connect</li> </ol>	ted KVA (New	r):	24.2			•	_					100071	Tidoc	
	2. Deman	d KVA(New):		30.3											
	3. Contrac	tor shall mate	h existing AIC F	Rating.											
			"EX" the load is												
			le for conducto												

	L2 Conductor Voltage Drop Table Per Charging Station									
<175FT	175FT-200FT	200FT-255FT	255FT-275FT	275FT-320FT	320FT-400FT	400FT-440FT	440FT-510FT	510FT-635FT	635FT-700FT	700FT-800FT
(2) #4 AWG +	(2) #4 AWG +	(2) #3 AWG+	(2) #2 AWG +	(2) #2 AWG+	(2) #1 AWG +	(2) #1/0 AWG +	(2) #1/0 AWG+	(2) #2/0 AWG +		(2) #3/0 AWG +
(2) #12 AWG +	(2) #10 AWG +	(2) #10 AWG +	(2) #10 AWG +	(2) #8 AWG+	(2) #8 AWG +	(2) #8 AWG +	(2) #6 AWG+	(2) #6 AWG+	(2) #6 AWG +	(2) #4 AWG+
(1) #6 AWG GND	(1) #6 AWG GND	(1) #4 AWG GND	(1) #4 AWG GND	(1) #4 AWG GND	(1) #4 AWG GND	(1) #3 AWG GND			(1) #1 AWG GND	(2) #4 AVVG T

- 1. CONTRACTOR SHALL BE RESPONSIBLE FOR DE-RATING CONDUCTORS WHEN 4 OR MORE CURRENT CARRYING CONDUCTORS ARE CARRIED IN THE SAME CONDUIT PER THE NEC.
- 2. THE DISTANCES IN THIS TABLE ARE TOTAL DISTANCES, NOT HORIZONTAL DISTANCES. INCLUDE VERTICAL RUNS AND JUNCTION BOX COIL LENGTH IN THE TOTAL CONDUCTOR DISTANCE.
- 3. WHEN MORE THAN ONE CHARGING STATION CIRCUIT CONDUCTORS ARE IN A CONDUIT, USE ONLY ONE SHARED EQUIPMENT GROUND CONDUCTOR.
- 4. WHEN INSTALLING #1/0 AWG OR LARGER CONDUCTORS FROM THE POWER SOURCE TO EVCS, INCLUDE MULTICONDUCTOR TAPS IN THE CLOSEST JUNCTION BOX PRIOR TO ENTERING THE EVCS OR IN THE EVCS ITSELF SO THAT #6 AWG CONDUCTORS CAN BE TERMINATED IN THE EVCS.

			Conduit Schedule	
Conduit Section	Conduit #	Conduit Size	Conductors	Installation Method
	1	2"	(See Voltage Drop Table)	Interior Mount /
	2	3/4" Min	Future Communications w/ Pull String	Directional Bore
	1	2"	(See Voltage Drop Table)	Interior Mount /
ь	2	3/4" Min	Future Communications w/ Pull String	Directional Bore

155 DE HARO STREET SAN FRANCISCO, CA 94103

# Kimley»Horn

WHITE PLAINS, NY 10601 Main: 914.368.9200 | www.kimley-horn.co

REV	DATE	DESCRIPTION	BY
1	01/21/2021	CD90s	TAS
2	03/18/2021	CD100s	TAS
3	09/15/2021	CD100 REVISION TO V4	CGE

ISSUE DATE

09/15/2021

ISSUED FOR

PERMIT




**STOP & SHOP #2702 CRANSTON** 


275 WARWICK AVENUE CRANSTON, RI 02905


SHEET TITLE

**ELECTRICAL ONE** LINE DIAGRAM & **PANEL SCHEDULE** 

E1-00

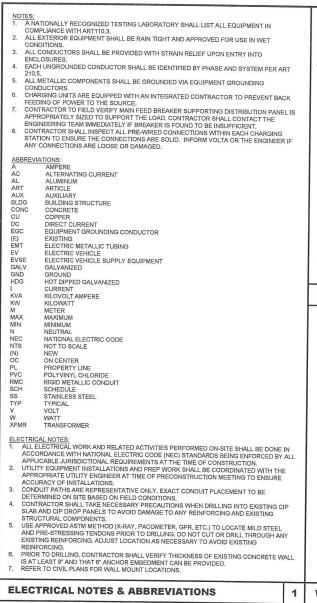


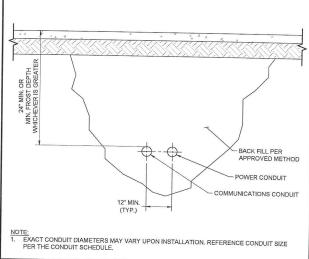

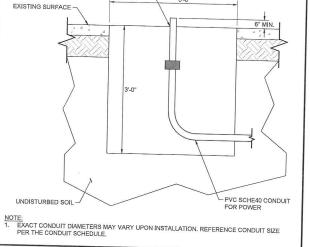

TRANSITION FROM PVC TO RMC FOR ANY EXPOSED CONDUIT AT GRADE TO STUB UP

**BORE PIT** 

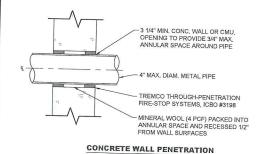

- NOTES:
  1. CONTRACTOR SHALL TAKE NECESSARY PRECAUTIONS WHEN DRILLING INTO EXISTING CIP SLAB AND CIP DROP PANELS TO AVOID DAMAGE TO ANY REINFORCING AND EXISTING STRUCTURAL COMPONENTS.
  2. USE APPROVED ASTM METHOD (X-RAY, PACOMETER, GPR, ECT.) TO LOCATED MILD STEEL AND PRE-STRESSING TENDONS PRIOR TO DRILLING, DO NOT CUT OR DRILL THROUGH ANY EXISTING REINFORCING, ADJUST LOCATION AS NECESSARY TO AVOID EXISTING REINFORCING.
  3. ALL PENETRATIONS MUST BE LOCATED A MINIMUM OF 18' AWAY FROM THE EDGE OF CONCRETE CONTRACT EOR IF VARIANCE IS REQUESTED.
  4. PENETRATIONS THROUGH WALLS AND FLOORS SHALL COMPLY WITH THE LOCAL AHJ LATEST BUILDING CODE CHAPTER 7 FIRE AND SMOKE PROTECTION FEATURES SECTIONS 709,6 AND 714.

PENETRATION DETAIL SCALE N.T.S. 155 DE HARO STREET

SAN FRANCISCO, CA 94103



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	F	REV	DATE	DESCRIPTION	BY
+		1	01/21/2021	CD90s	TAS
1	4	2	03/18/2021	CD100s	TAS
	4	3	09/15/2021	CD100 REVISION TO V4	CGI
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ISSUE DATE

09/15/2021

ISSUED FOR **PERMIT** 



(ELECTRICAL) IT IS A VIOLATION OF LAW FOR ANY PERSON UNLESS THEY ARE ACTING UNDER THE DIRECTION OF A LICENSED PROFESSIONAL ENGINEER, TO ALTER THIS DOCUMENT.

**STOP & SHOP #2702 CRANSTON** 

275 WARWICK AVENUE CRANSTON, RI 02905

SHEET TITLE

**ELECTRICAL NOTES & DETAILS** 

> SHEET NUMBER **E2-00**

